



**Front Elevation** scale 1:15

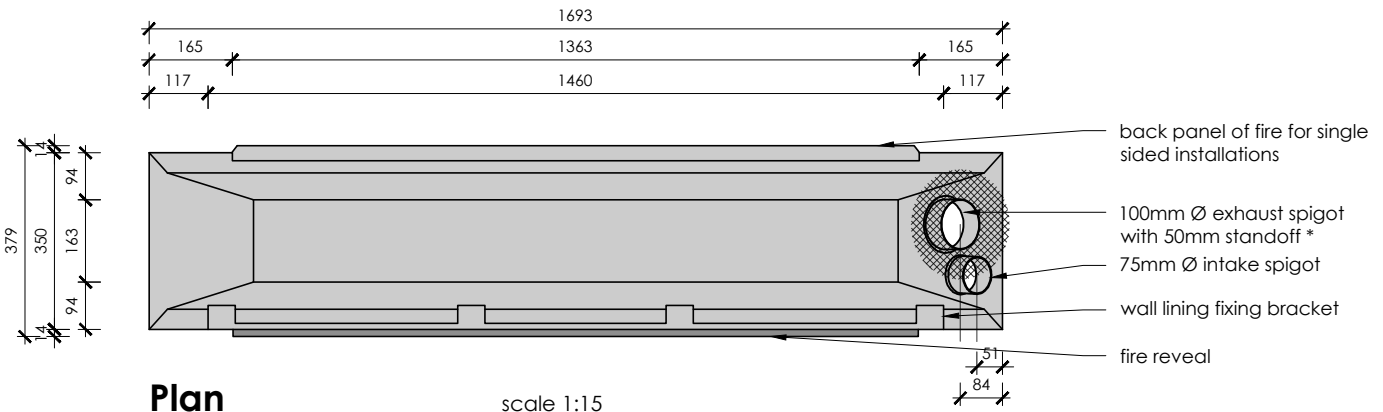

**Plan** scale 1:15

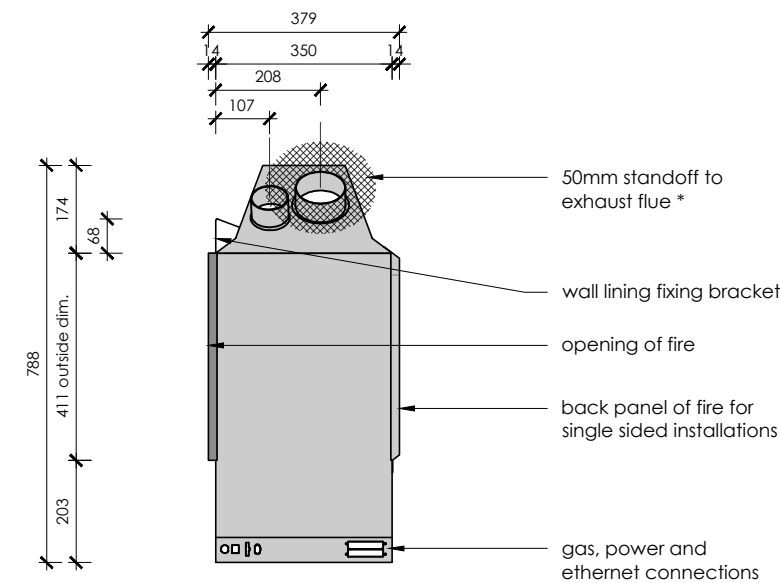

**Side Elevation** scale 1:10

**note:**

- DO NOT SCALE OFF THESE DRAWINGS
- All dimensions are in mm.
- Flue clearances may affect the design of combustible building materials above the chassis.
- DS1400 has 3 wall lining finishing options:
  - **Frameless** - 10-20mm linings
  - **Bevelled Fascia** - 13mm wall linings
  - **Linear Trim** - 10-20mm wall linings
- For flue system requirements refer to Sec. C of the **ESCEA DS Series Install Manual**

\*50mm clearance to all combustible surfaces for the first 1200mm of the exhaust flue - zero clearance beyond this point

**IMPORTANT:**

This technical sheet must be read in conjunction with the Escea DS Series Installation Manual, the latest version can be found on our website [www.escea.com/nz/technical/](http://www.escea.com/nz/technical/)

Contact the **ESCEA Architectural Advisory Team** for assistance with installation of this fire - [aa@escea.com](mailto:aa@escea.com)

file: DS SERIES MASTER FILE.dwg	scale: <b>1:15</b>	ecn: <b>ECN-2681</b>	drawing no: <b>EDA-229</b>	revision: <b>001</b>	date: <b>15.11.2017</b>	drawn: <b>MG</b>
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